

LOOK UP AND LIVE

OVERHEAD POWER LINES IN VICINITY OF WORKS.

ENSURE ALL POWER LINES ARE CLEARLY MARKED WITH ORANGE WEATHERPROOF TAPE OR RIBBON


ALL WORKS ARE TO BE CARRIED OUT IN ACCORDANCE WITH THE NSW WORK COVER 'WORK NEAR OVERHEAD POWER LINES CODE OF PRACTICE 2006'

<http://www.workcover.nsw.gov.au/health-and-safety/industry-safety/electrical-and-power/power-lines/publications/work-near-overhead-power-lines-code-of-practice-2006>

PROPOSED SPORTS COMPLEX O'CONNELL ROAD OBERON NSW 2787

FOR CROSSMULLER

THERE MAY BE EXISTING SERVICES WITHIN THE WORKS AREA THAT ARE NOT SHOWN ON THESE PLANS. THE CONTRACTOR IS TO LOCATE ALL SERVICES PRIOR TO THE COMMENCEMENT OF WORKS.

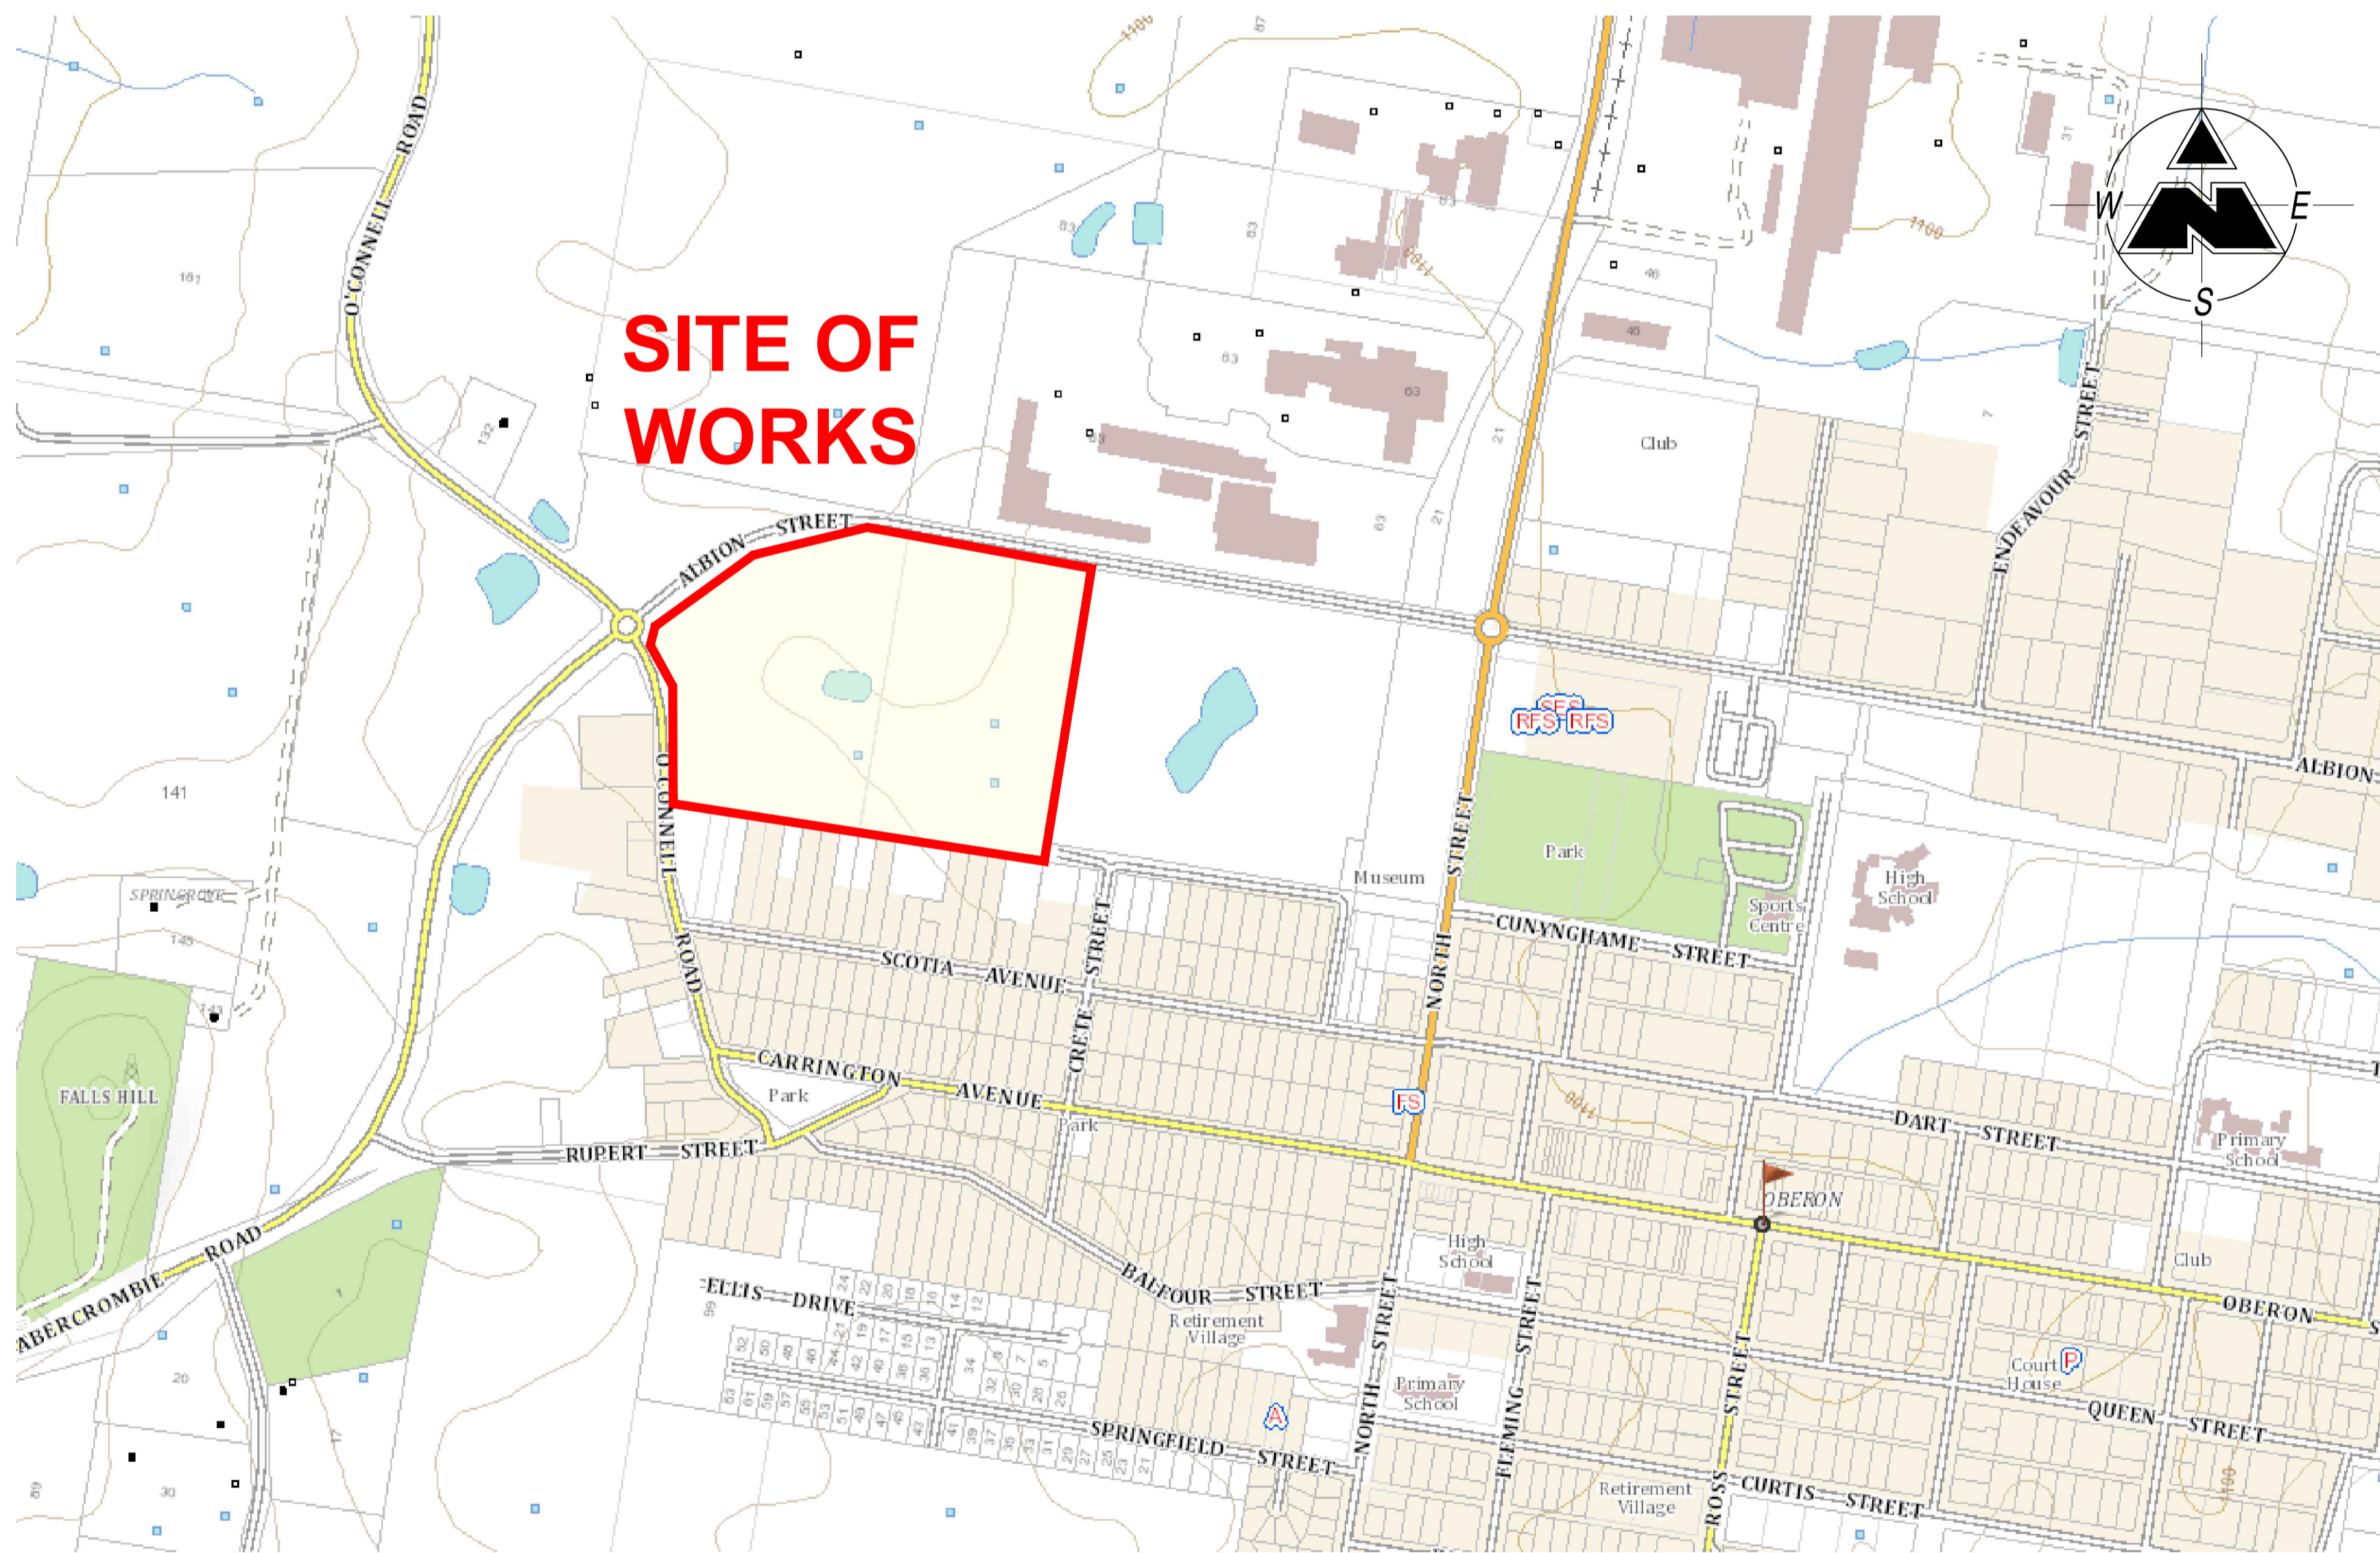

LOCALITY PLAN
N.T.S.

DRAWING INDEX	
Dwg No.	Title
G01	COVER SHEET
G02	GENERAL ARRANGEMENT PLAN
EW01	BULK EARTHWORKS PLAN - ACCESS & CARPARK
EW02	EARTHWORKS CROSS-SECTIONS
EW03	BULK EARTHWORKS PLAN - WHOLE SITE
C01	CIVIL WORKS PLAN
C02	SITE GRADING PLAN
SW01	STORMWATER CALCULATIONS

Legend

- Bank / Batter
- Kerb
- Edge Of Seal / Bitumen
- Edge Of Gravel
- Building
- Swale
- Stormwater Line
- Proposed Building
- Proposed Seal/ Bitumen
- Proposed Concrete
- Proposed Gravel
- Proposed Field
- Proposed Landscaping
- Proposed Water/ Basin
- Existing Landscaping

PLOT INFO: ...2023.0913-Civil-B.dwg, DATE: Oct 30, 2023 - 11:27:36

Amend	Date	Description	By	Amend	Date	Description	By
B	29/09/23	REVISED SITE LEVELS AND EARTHWORKS VOLUMES	TM				
A	25/09/23	FOR APPROVAL	JB				

Approved for Construction:

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Drawn: JB
Designed: TM
Checked: GBL
Scale (A1): AS SHOWN
Date: 25/09/23

FOR APPROVAL

Garth Dean
B.E. GDSTT FIEAust CPEng NER
APEC Engineer IntPE (Aus) RBP
(Vic/NT)

...2023.0913-Civil-B.dwg

PROPOSED SPORTS COMPLEX
O'CONNELL ROAD
OBERON NSW 2787


COVER SHEET

CROSSMULLER

CALARE CIVIL
CONSULTING ENGINEERS

170 RANKIN STREET,
BATHURST, N.S.W. 2795
Tel: (02) 63323343 Fax: (02) 63318210

Job No.	2023.0913
DWG. No.	G01
Issue	B
No. in set	8

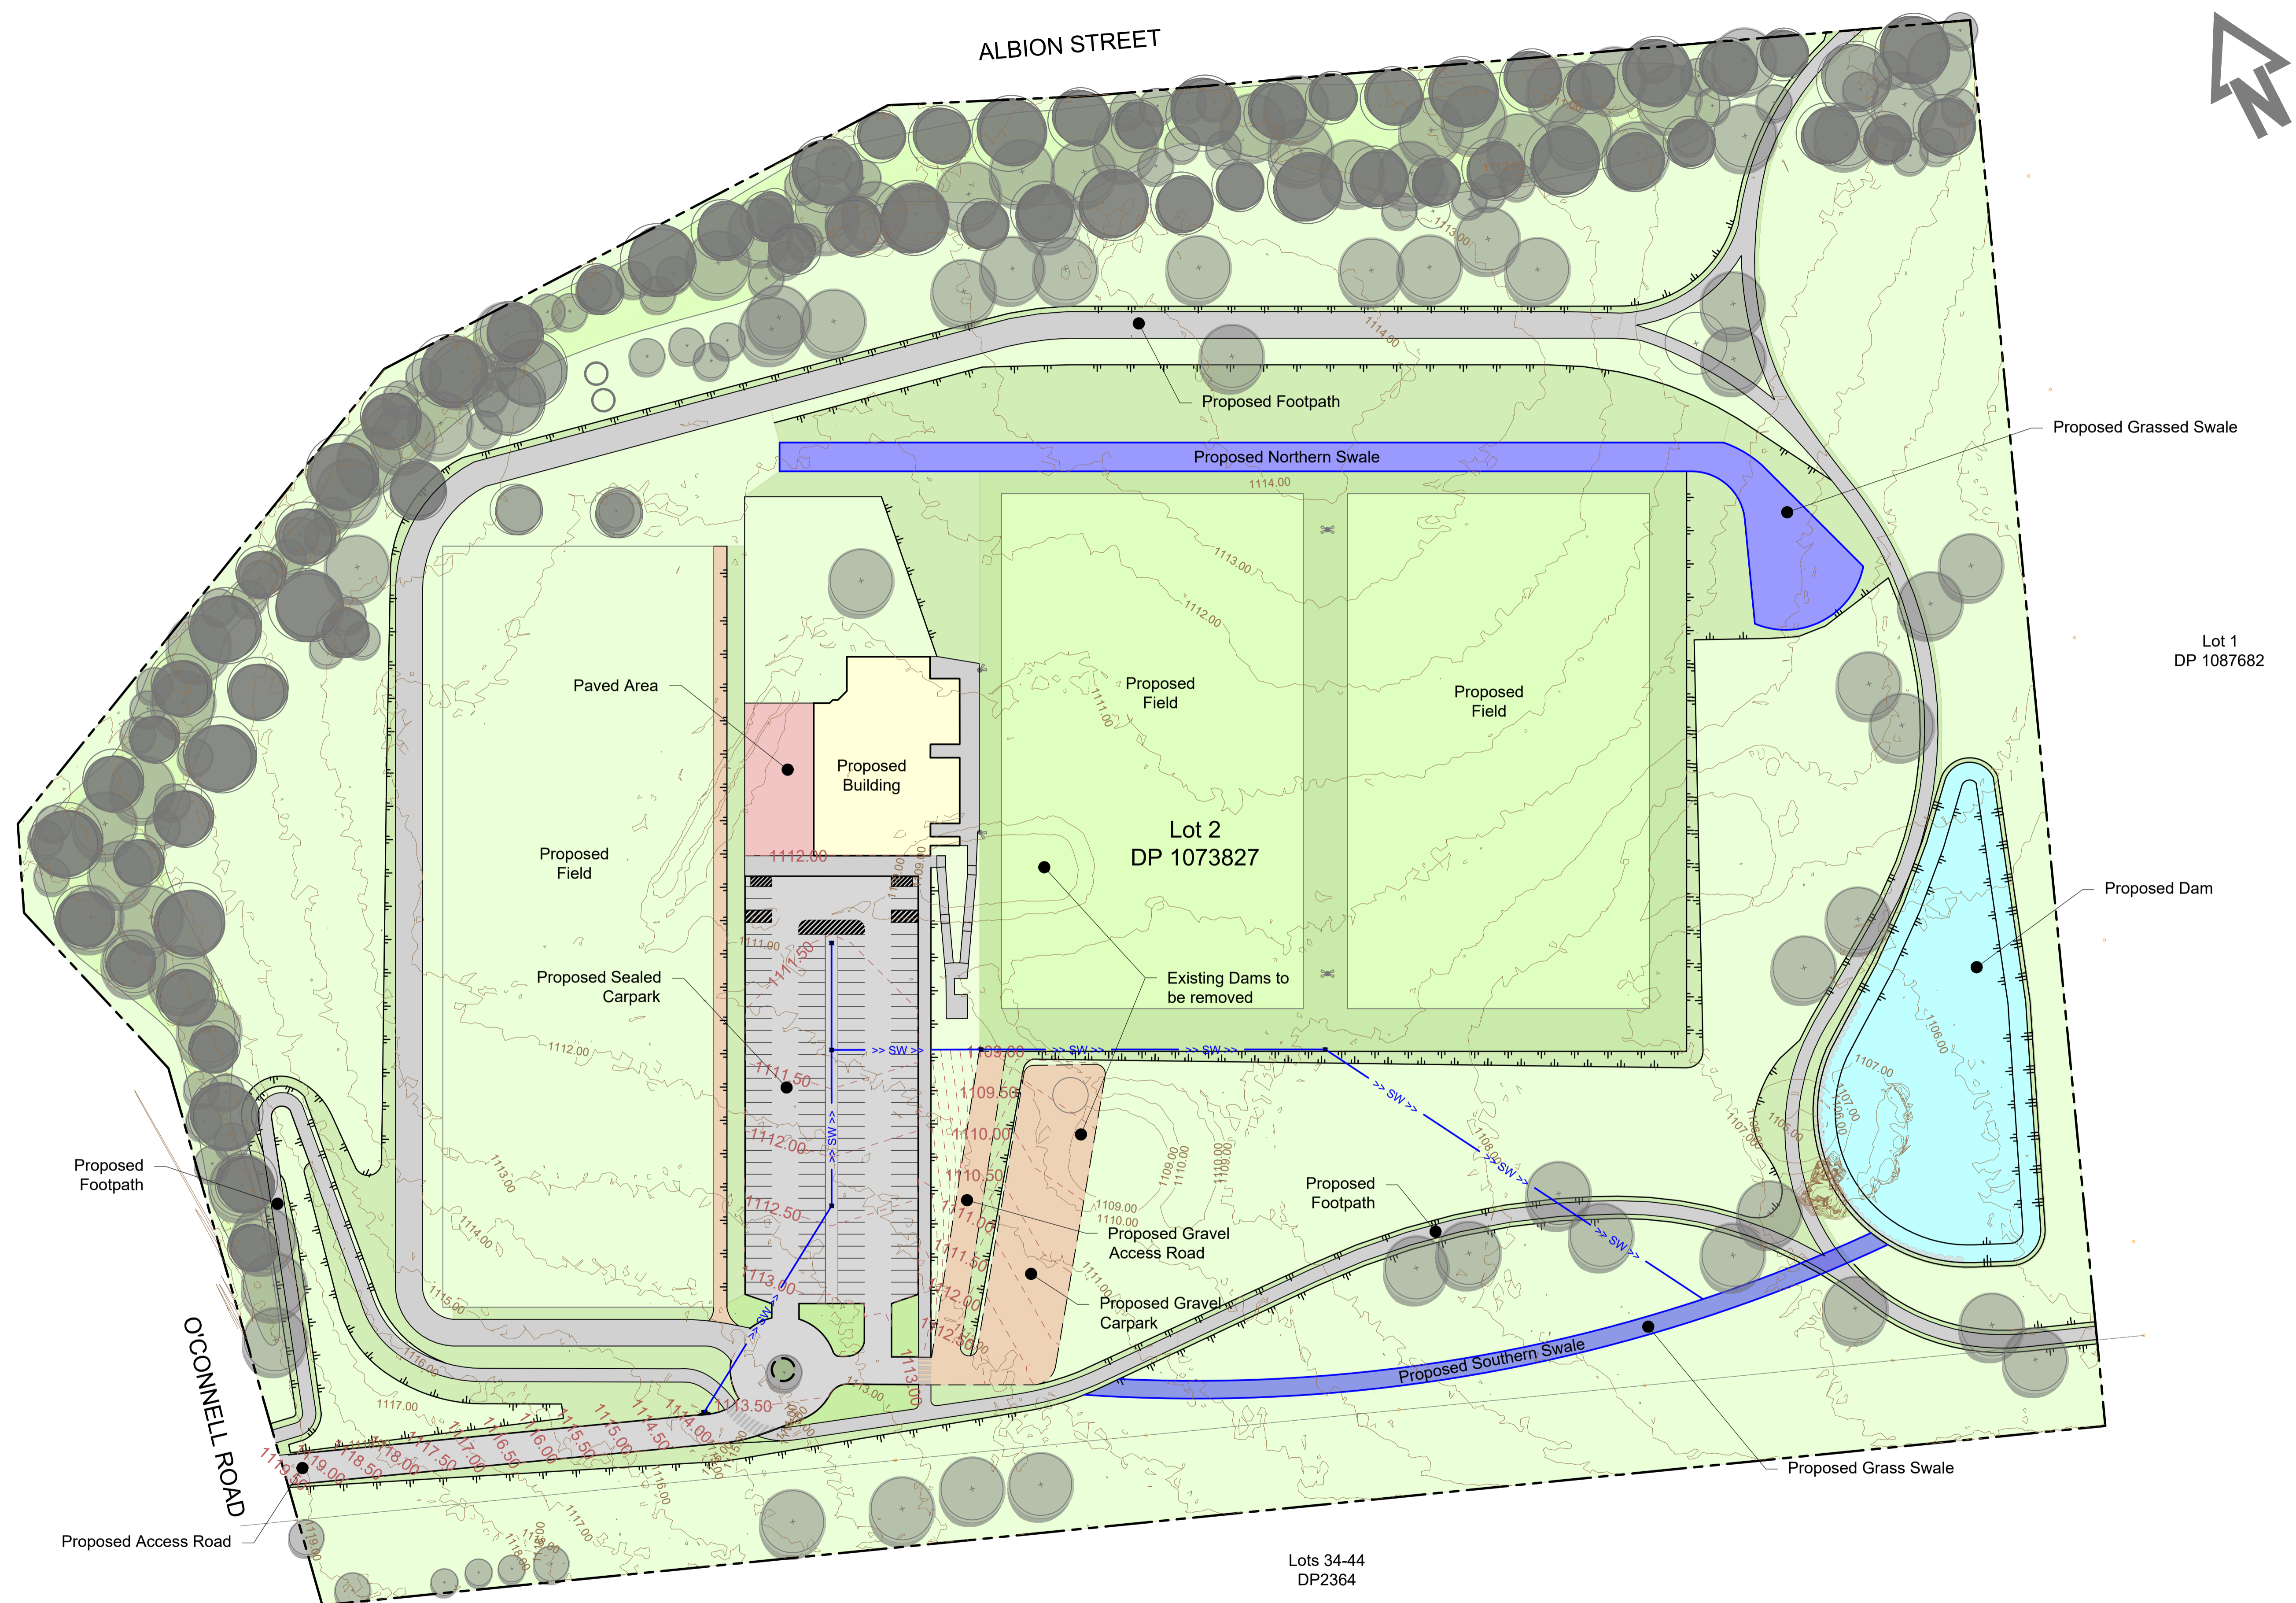

PLOT INFO: ...2023.0913-Civil-B.dwg, DATE: Oct 30, 2023 - 11:27:55

Amend	Date	Description	By	Amend	Date	Description	By
B	29/09/23	REVISED SITE LEVELS AND EARTHWORKS VOLUMES	TM				
A	25/09/23	FOR APPROVAL	JB				

Approved for Construction:

Garth Dean
 B.E. GDSTT FIEAust CPEng NER
 APEC Engineer IntPE (Aus) RBP
 (Vic/NT)

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Drawn: JB
 Designed: TM
 Checked: GBL
 Scale (A1): 1:750
 Date: 25/09/23

FOR APPROVAL

...2023.0913-Civil-B.dwg

PROPOSED SPORTS COMPLEX
 O'CONNELL ROAD
 OBERON NSW 2787

GENERAL ARRANGEMENT PLAN

CROSSMULLER

CALARE CIVIL
 CONSULTING ENGINEERS

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Job No.
2023.0913

DWG. No. Issue
G02 B

No. in set
8

NOTES:


- Earthworks Volumes Include;
- Entrance Road and Carpark Only
 - Excavation to pavement sub-grade (200mm)
 - Topsoil Strip (Assumed 200mm)

- Earthworks Volumes DO NOT Include;
- Earthworks for any playing fields, footpaths, dams, building site or any other infrastructure
 - Trench volumes for services
 - Bulking factor

Elevations Table				
Number	Minimum Elevation	Maximum Elevation	Volume	Color
1	-2.000	-1.000	4m ³	Orange
2	-1.000	0.000	788m ³	Light Green
3	0.000	1.000	3702m ³	Light Green
4	1.000	2.000	788m ³	Light Green
5	2.000	3.000	63m ³	Light Green
6	3.000	4.000	4m ³	Light Green

Total Cut
959m³

Total Fill
2648m³

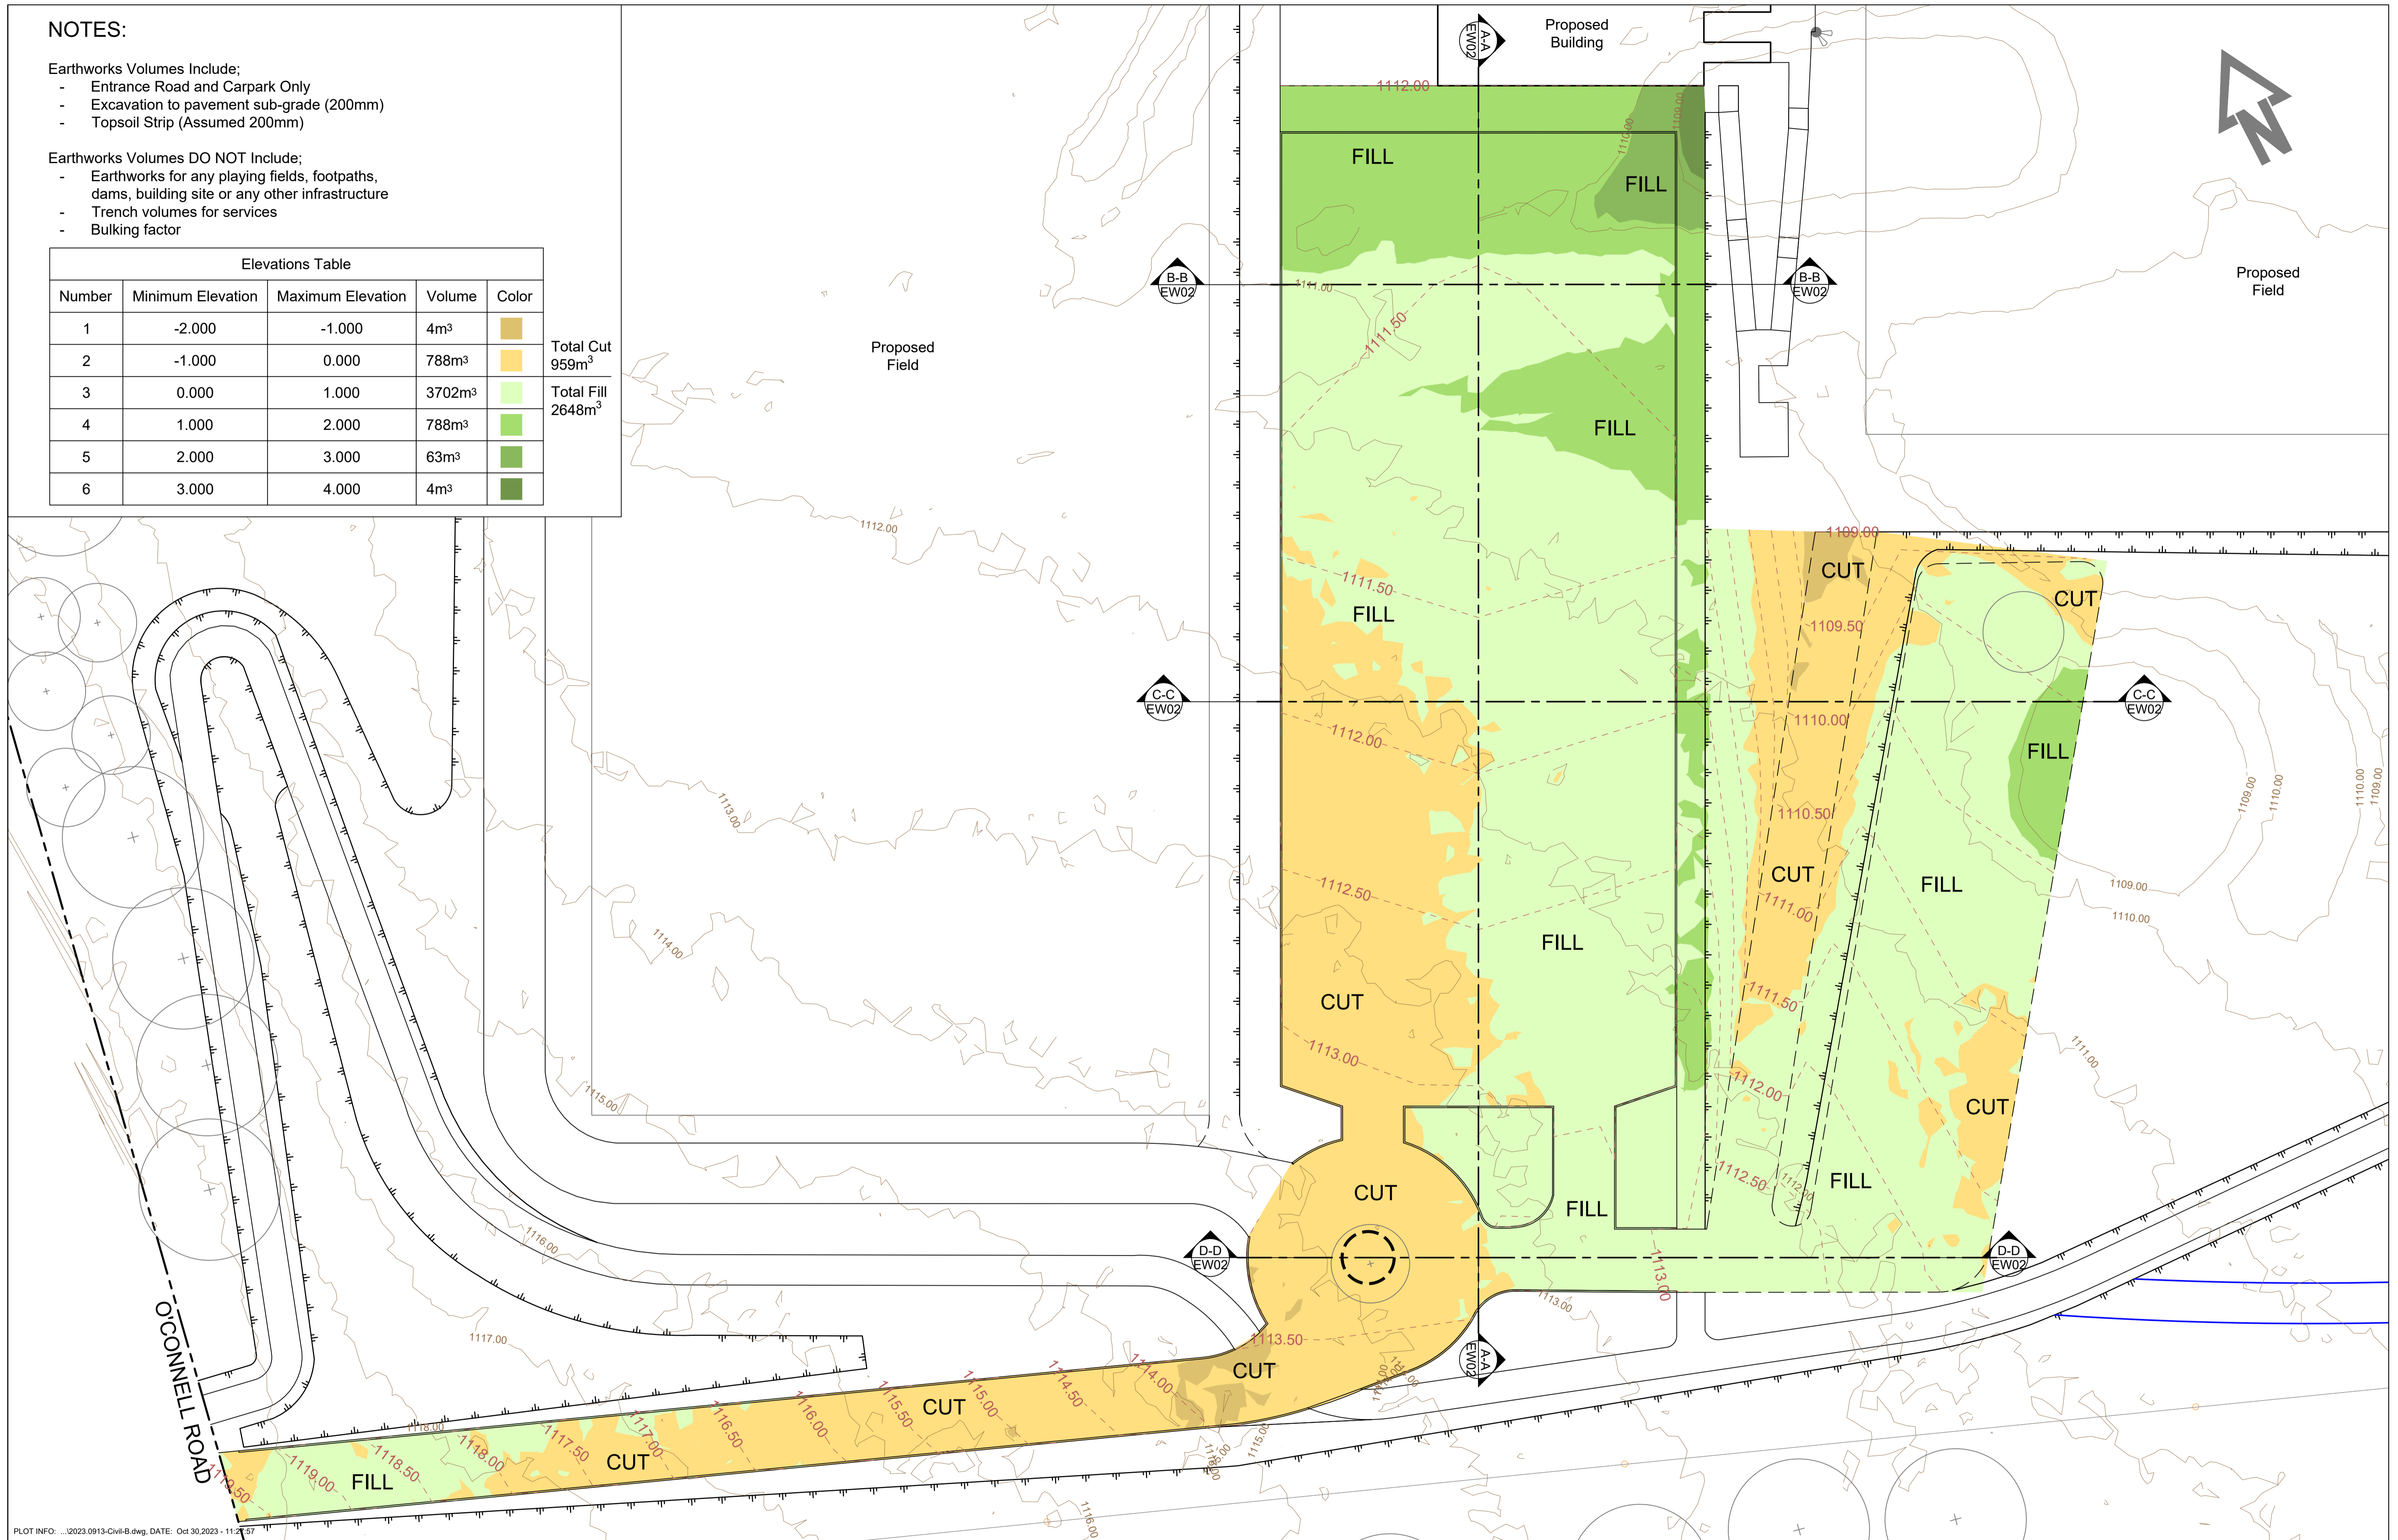

PLOT INFO: ...2023.0913-Civil-B.dwg, DATE: Oct 30, 2023 - 11:27:57

Amend	Date	Description	By	Amend	Date	Description	By
B	29/09/23	REVISED SITE LEVELS AND EARTHWORKS VOLUMES	TM				
A	25/09/23	FOR APPROVAL	JB				

Approved for Construction:

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Drawn: JB
Designed: TM
Checked: GBL
Scale (A1): 1:300
Date: 25/09/23

FOR APPROVAL

Garth Dean
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...2023.0913-Civil-B.dwg

PROPOSED SPORTS COMPLEX
O'CONNELL ROAD
OBERON NSW 2787

BULK EARTHWORKS PLAN -
ACCESS & CARPARK

CROSSMULLER


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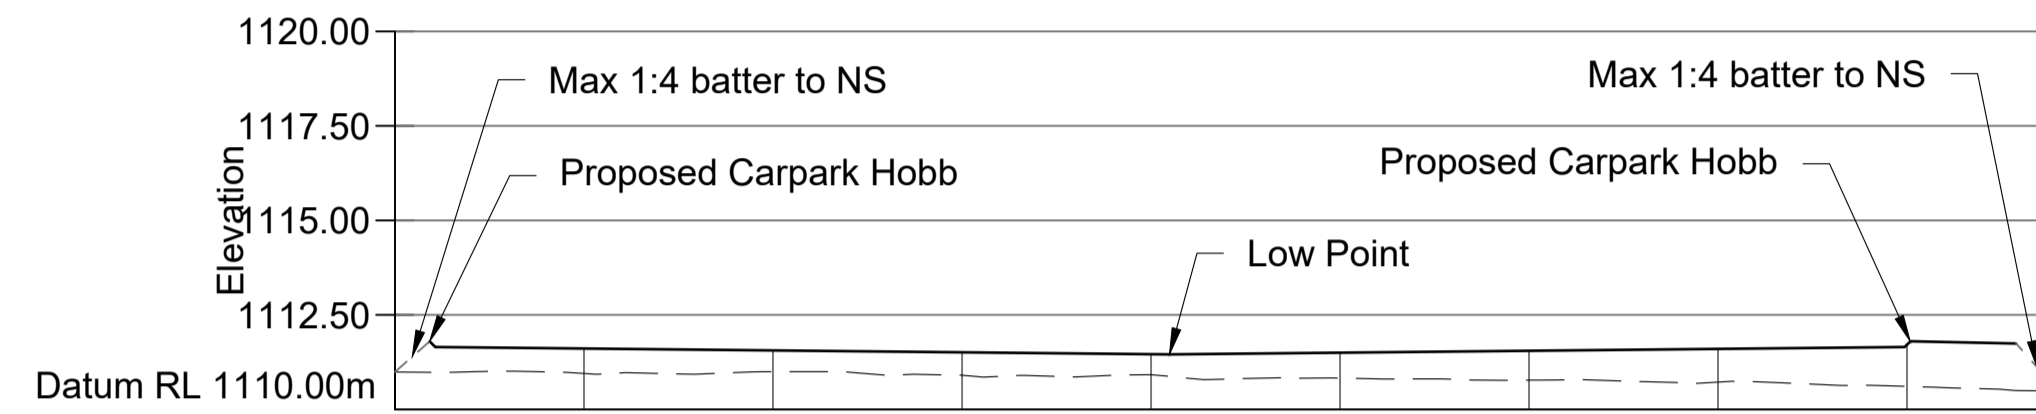
Job No.
2023.0913

DWG. No. Issue
EW01 B


No. in set
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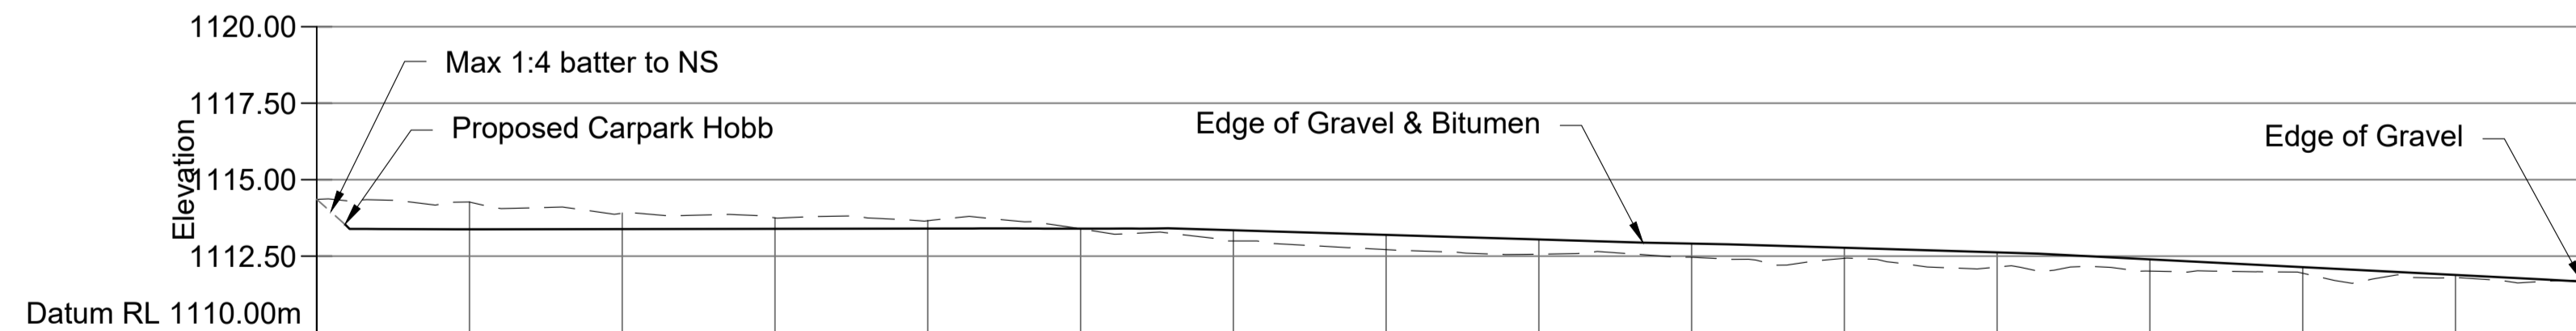
Section A-A
Scale 1:100



Section B-B
Scale 1:100

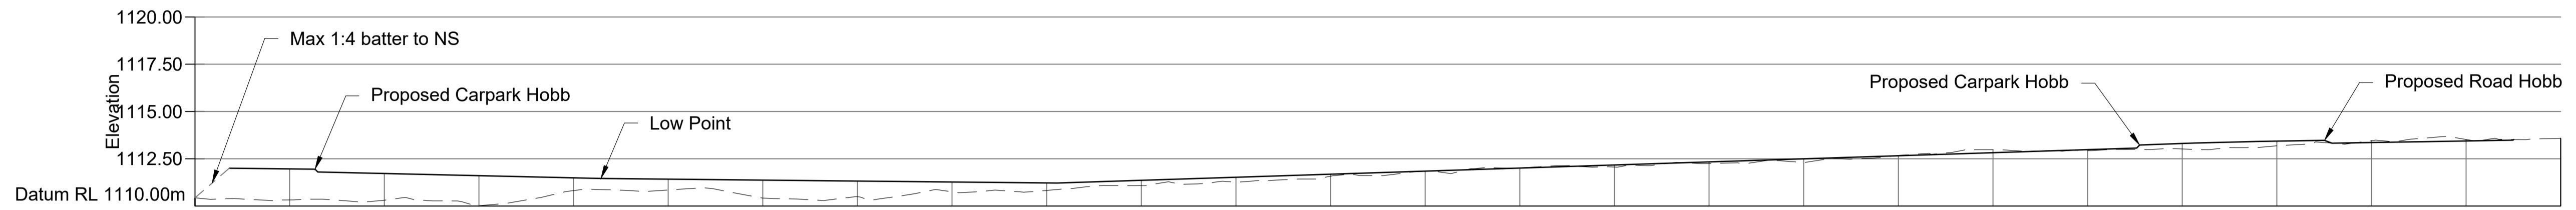

Section C-C
Scale 1:100

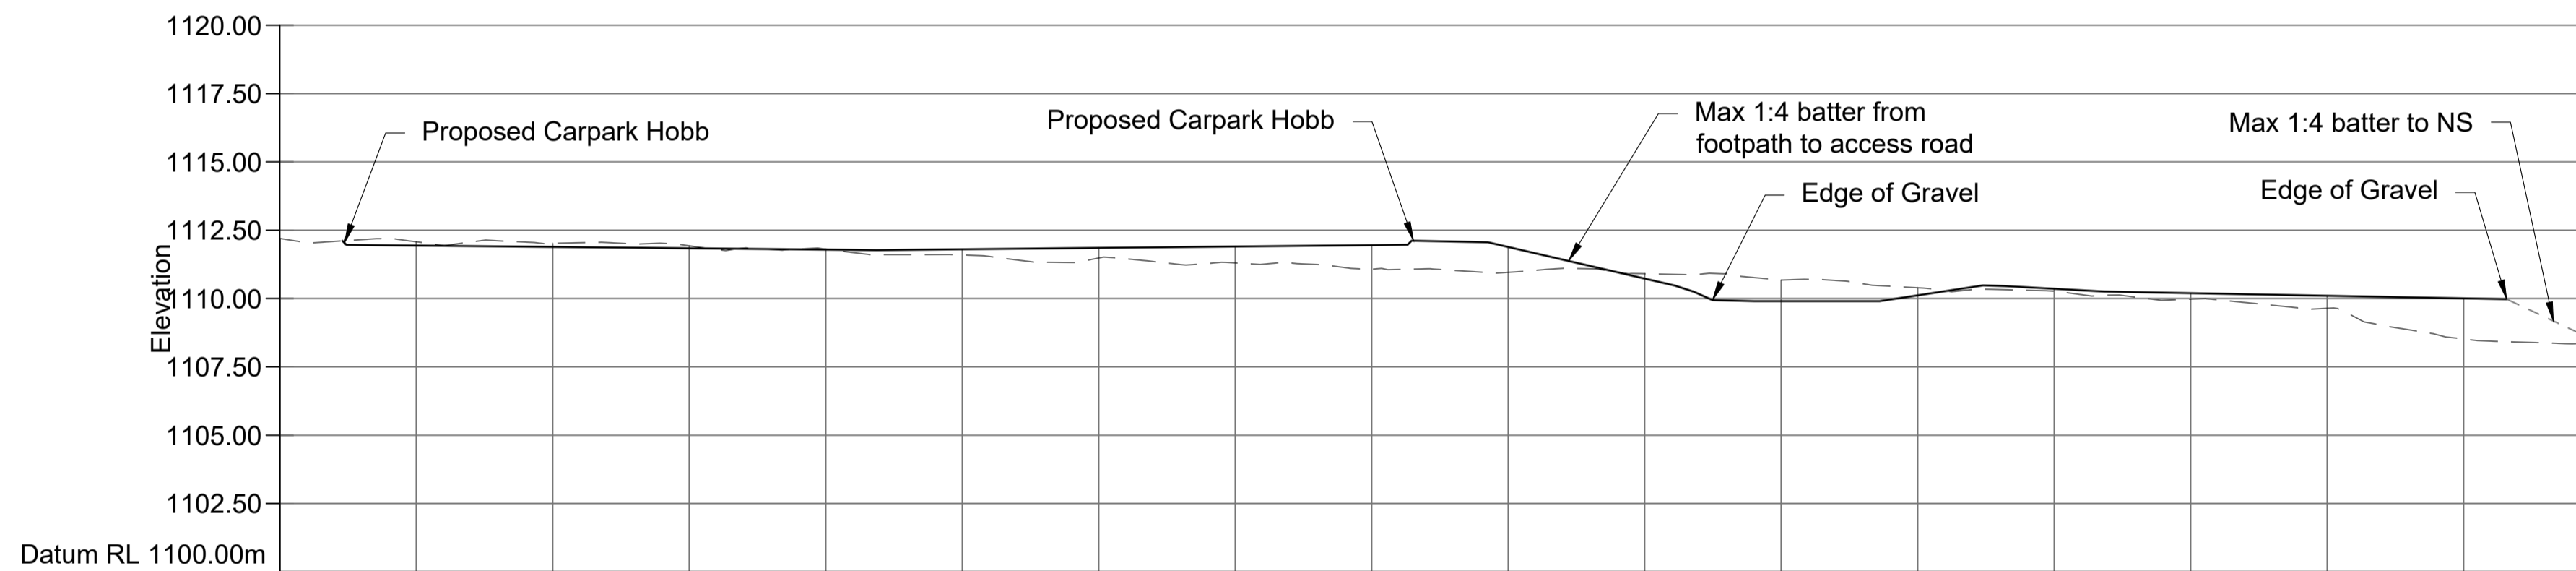

Section D-D
Scale 1:100

PLOT INFO: ...2023.0913-Civil-B.dwg, DATE: Oct 30, 2023 - 11:27:58

Amend	Date	Description	By	Amend	Date	Description	By
B	29/09/23	REVISED SITE LEVELS AND EARTHWORKS VOLUMES	TM				
A	25/09/23	FOR APPROVAL	JB				

Approved for Construction:

Garth Dean
 B.E. GDSTT FIEAust CPEng NER
 APEC Engineer IntPE (Aus) RBP
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Drawn: JB
 Designed: TM
 Checked: GBL
 Scale (A1): 1:100
 Date: 25/09/23

FOR APPROVAL

...2023.0913-Civil-B.dwg

PROPOSED SPORTS COMPLEX
 O'CONNELL ROAD
 OBERON NSW 2787

EARTHWORKS CROSS-SECTIONS

CROSSMULLER

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Job No.
2023.0913

DWG. No. Issue
EW02 B

No. in set
8

NOTES:







Earthworks Volumes Include;

- Entrance road and carpark to Calare Civil design with excavation to pavement sub-grade (200mm)
- Rest of site earthworks to Space Urban design with excavation to pavement sub-grade (200mm)
- Topsoil Strip (Whole Site - assumed 200mm)

Earthworks Volumes DO NOT Include;


- Trench volumes for services
- Bulking factor
- Northern and southern swale volumes

Elevations Table

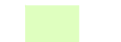Number	Minimum Elevation	Maximum Elevation	Volume	Color
1	-9.000	-6.750	0m ³	
2	-6.750	-4.500	341m ³	
3	-4.500	-2.250	10323m ³	
4	-2.250	0.000	50807m ³	
5	0.000	2.250	42318m ³	
6	2.250	4.500	429m ³	

Total Cut
69562m³

Total Fill
42898m³

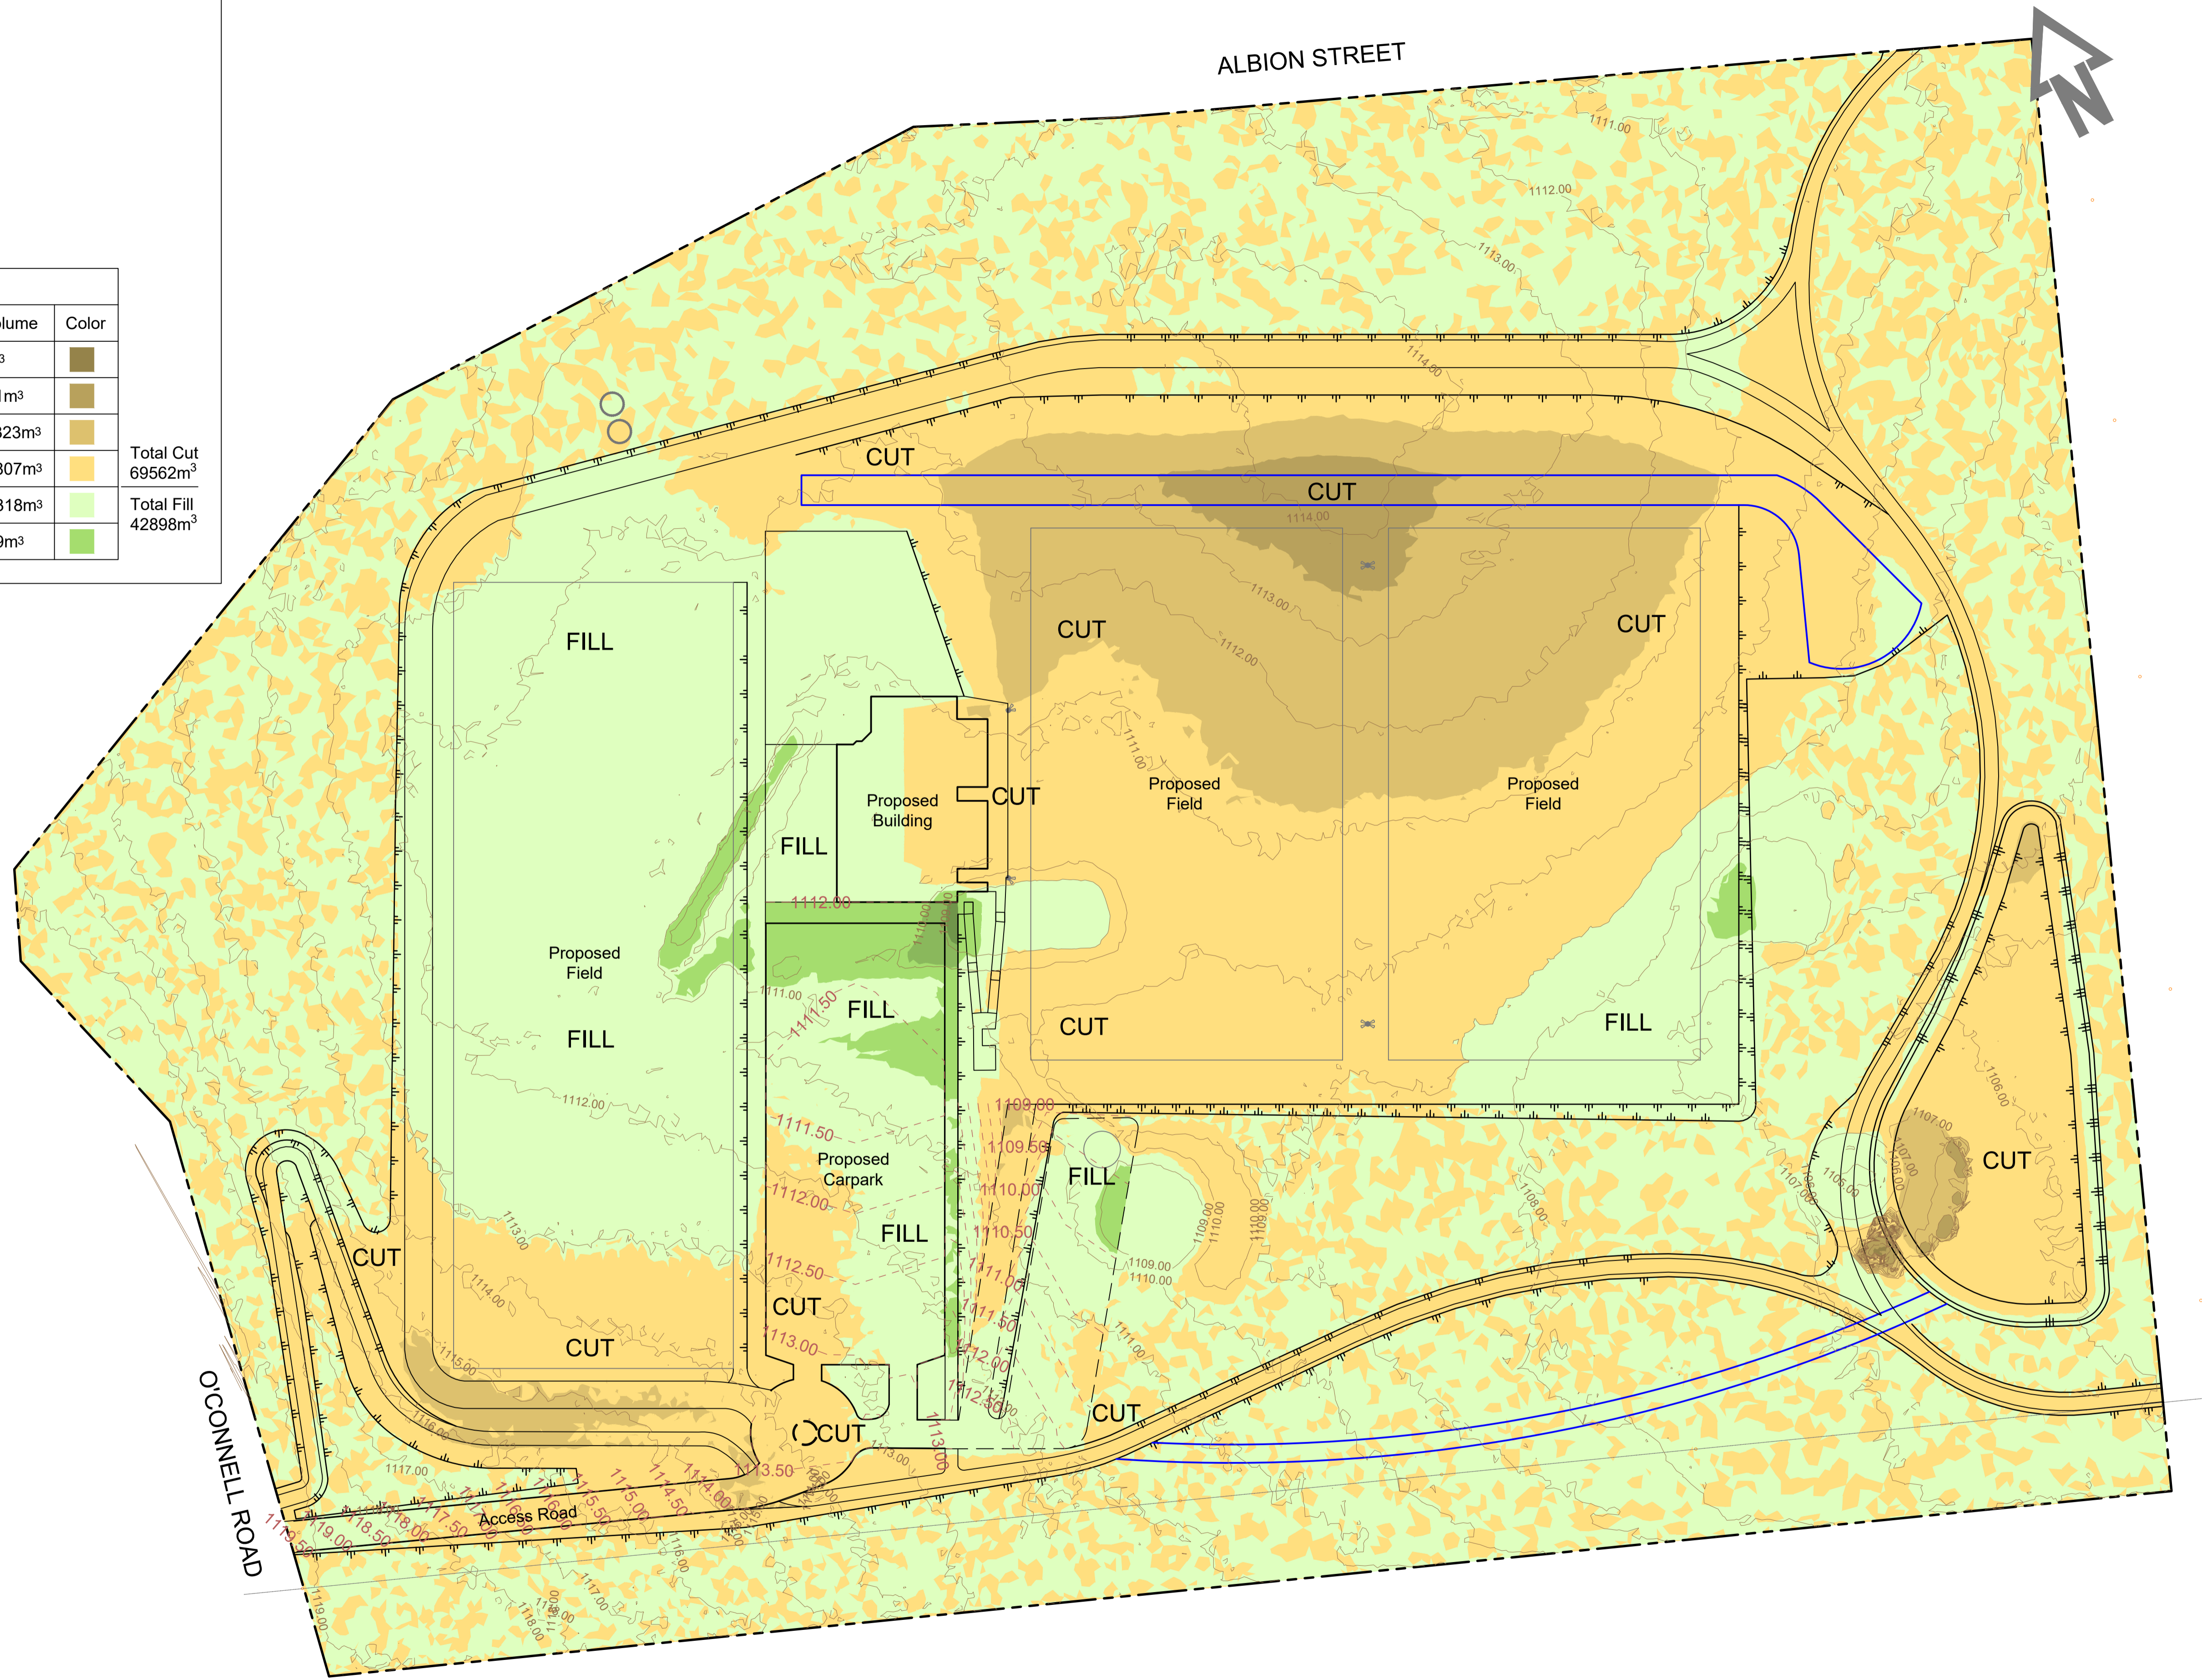

PLOT INFO: ...2023.0913-Civil-B.dwg, DATE: Oct 30, 2023 - 11:28:03

Amend	Date	Description	By	Amend	Date	Description	By
B	29/09/23	REVISED SITE LEVELS AND EARTHWORKS VOLUMES	TM				
A	25/09/23	FOR APPROVAL	JB				

Approved for Construction:

Garth Dean
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(Vic/NT)

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Drawn: JB
Designed: TM
Checked: GBL
Scale (A1): 1:750
Date: 25/09/23

FOR APPROVAL

...2023.0913-Civil-B.dwg

PROPOSED SPORTS COMPLEX
O'CONNELL ROAD
OBERON NSW 2787

BULK EARTHWORKS PLAN -
WHOLE SITE

CROSSMULLER


CALARE CIVIL
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170 RANKIN STREET,
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Job No.
2023.0913

DWG. No. Issue
EW03 B

No. in set
8



PLOT INFO: ...2023.0913-Civil-B.dwg, DATE: Oct 30, 2023 - 11:28:30

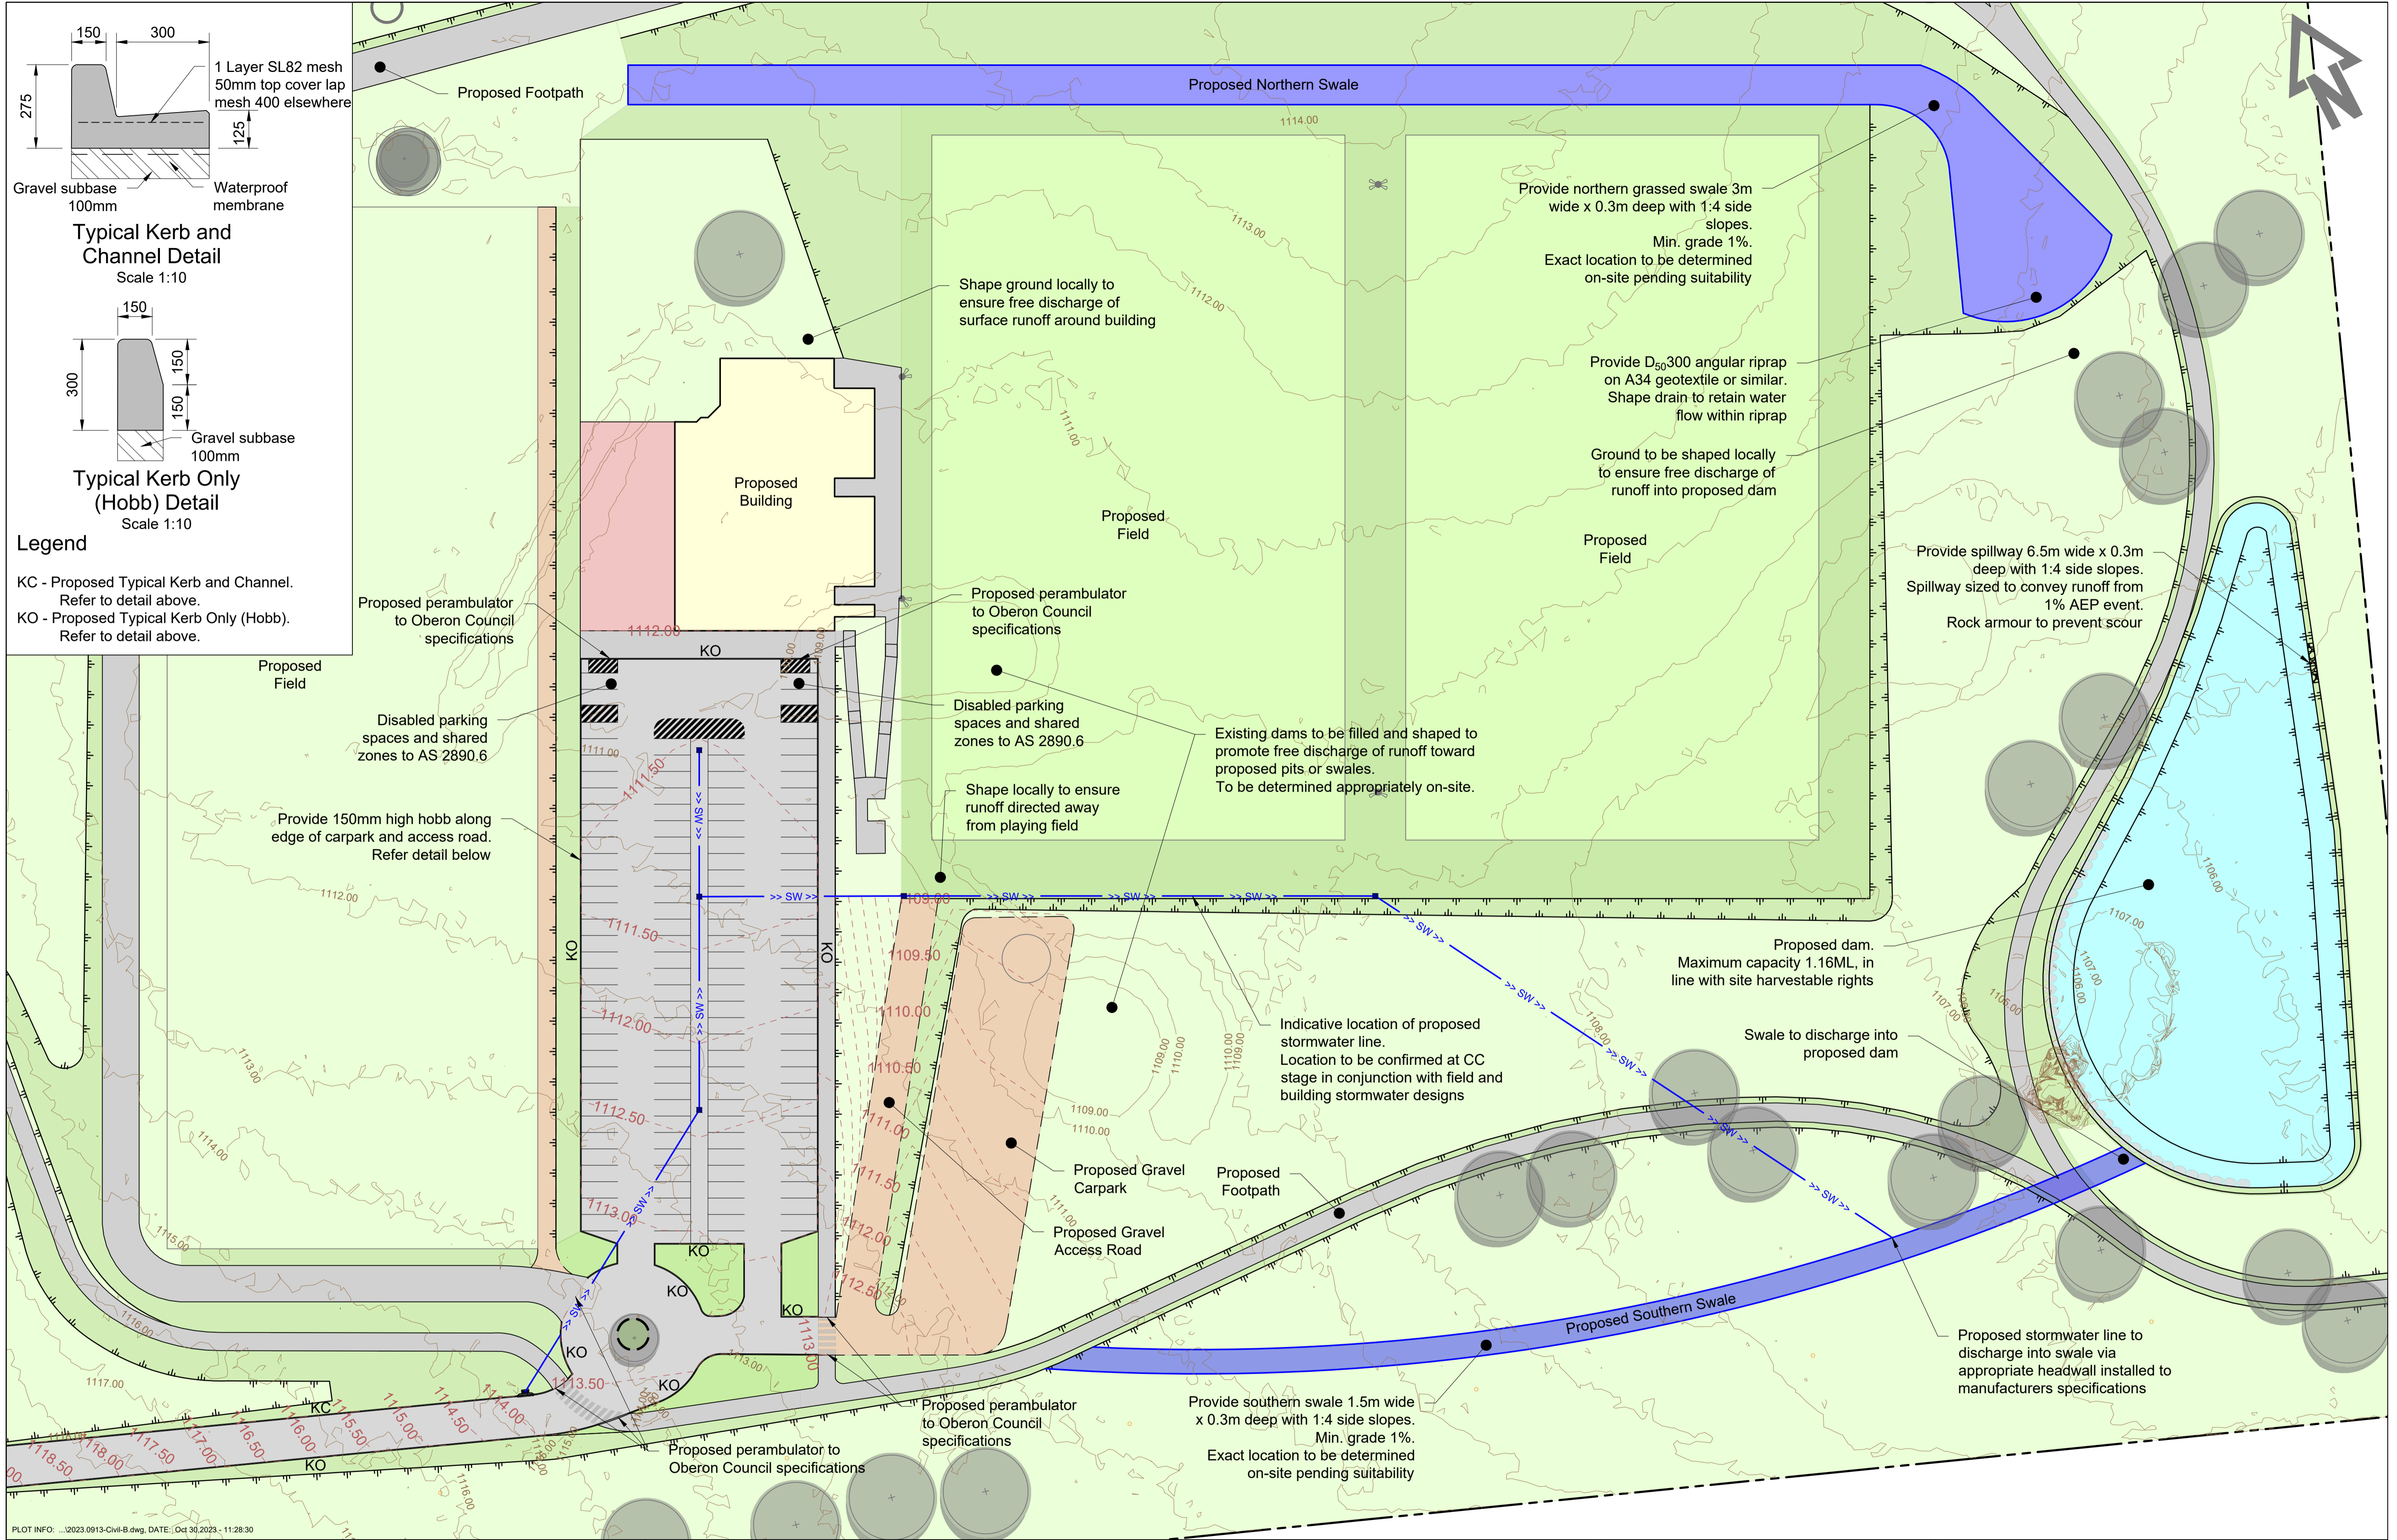Amend	Date	Description	By	Amend	Date	Description	By
B	29/09/23	REVISED SITE LEVELS AND EARTHWORKS VOLUMES	TM				
A	25/09/23	FOR APPROVAL	JB				

Approved for Construction:

Garth Dean
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Drawn: JB
Designed: TM
Checked: GBL
Scale (A1): 1:500
Date: 25/09/23

FOR APPROVAL

...2023.0913-Civil-B.dwg

PROPOSED SPORTS COMPLEX
O'CONNELL ROAD
OBERON NSW 2787

CIVIL WORKS PLAN

CROSSMULLER


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Tel: (02) 63323343 Fax: (02) 63318210

Job No.
2023.0913


DWG. No. Issue
C01 B

No. in set
8

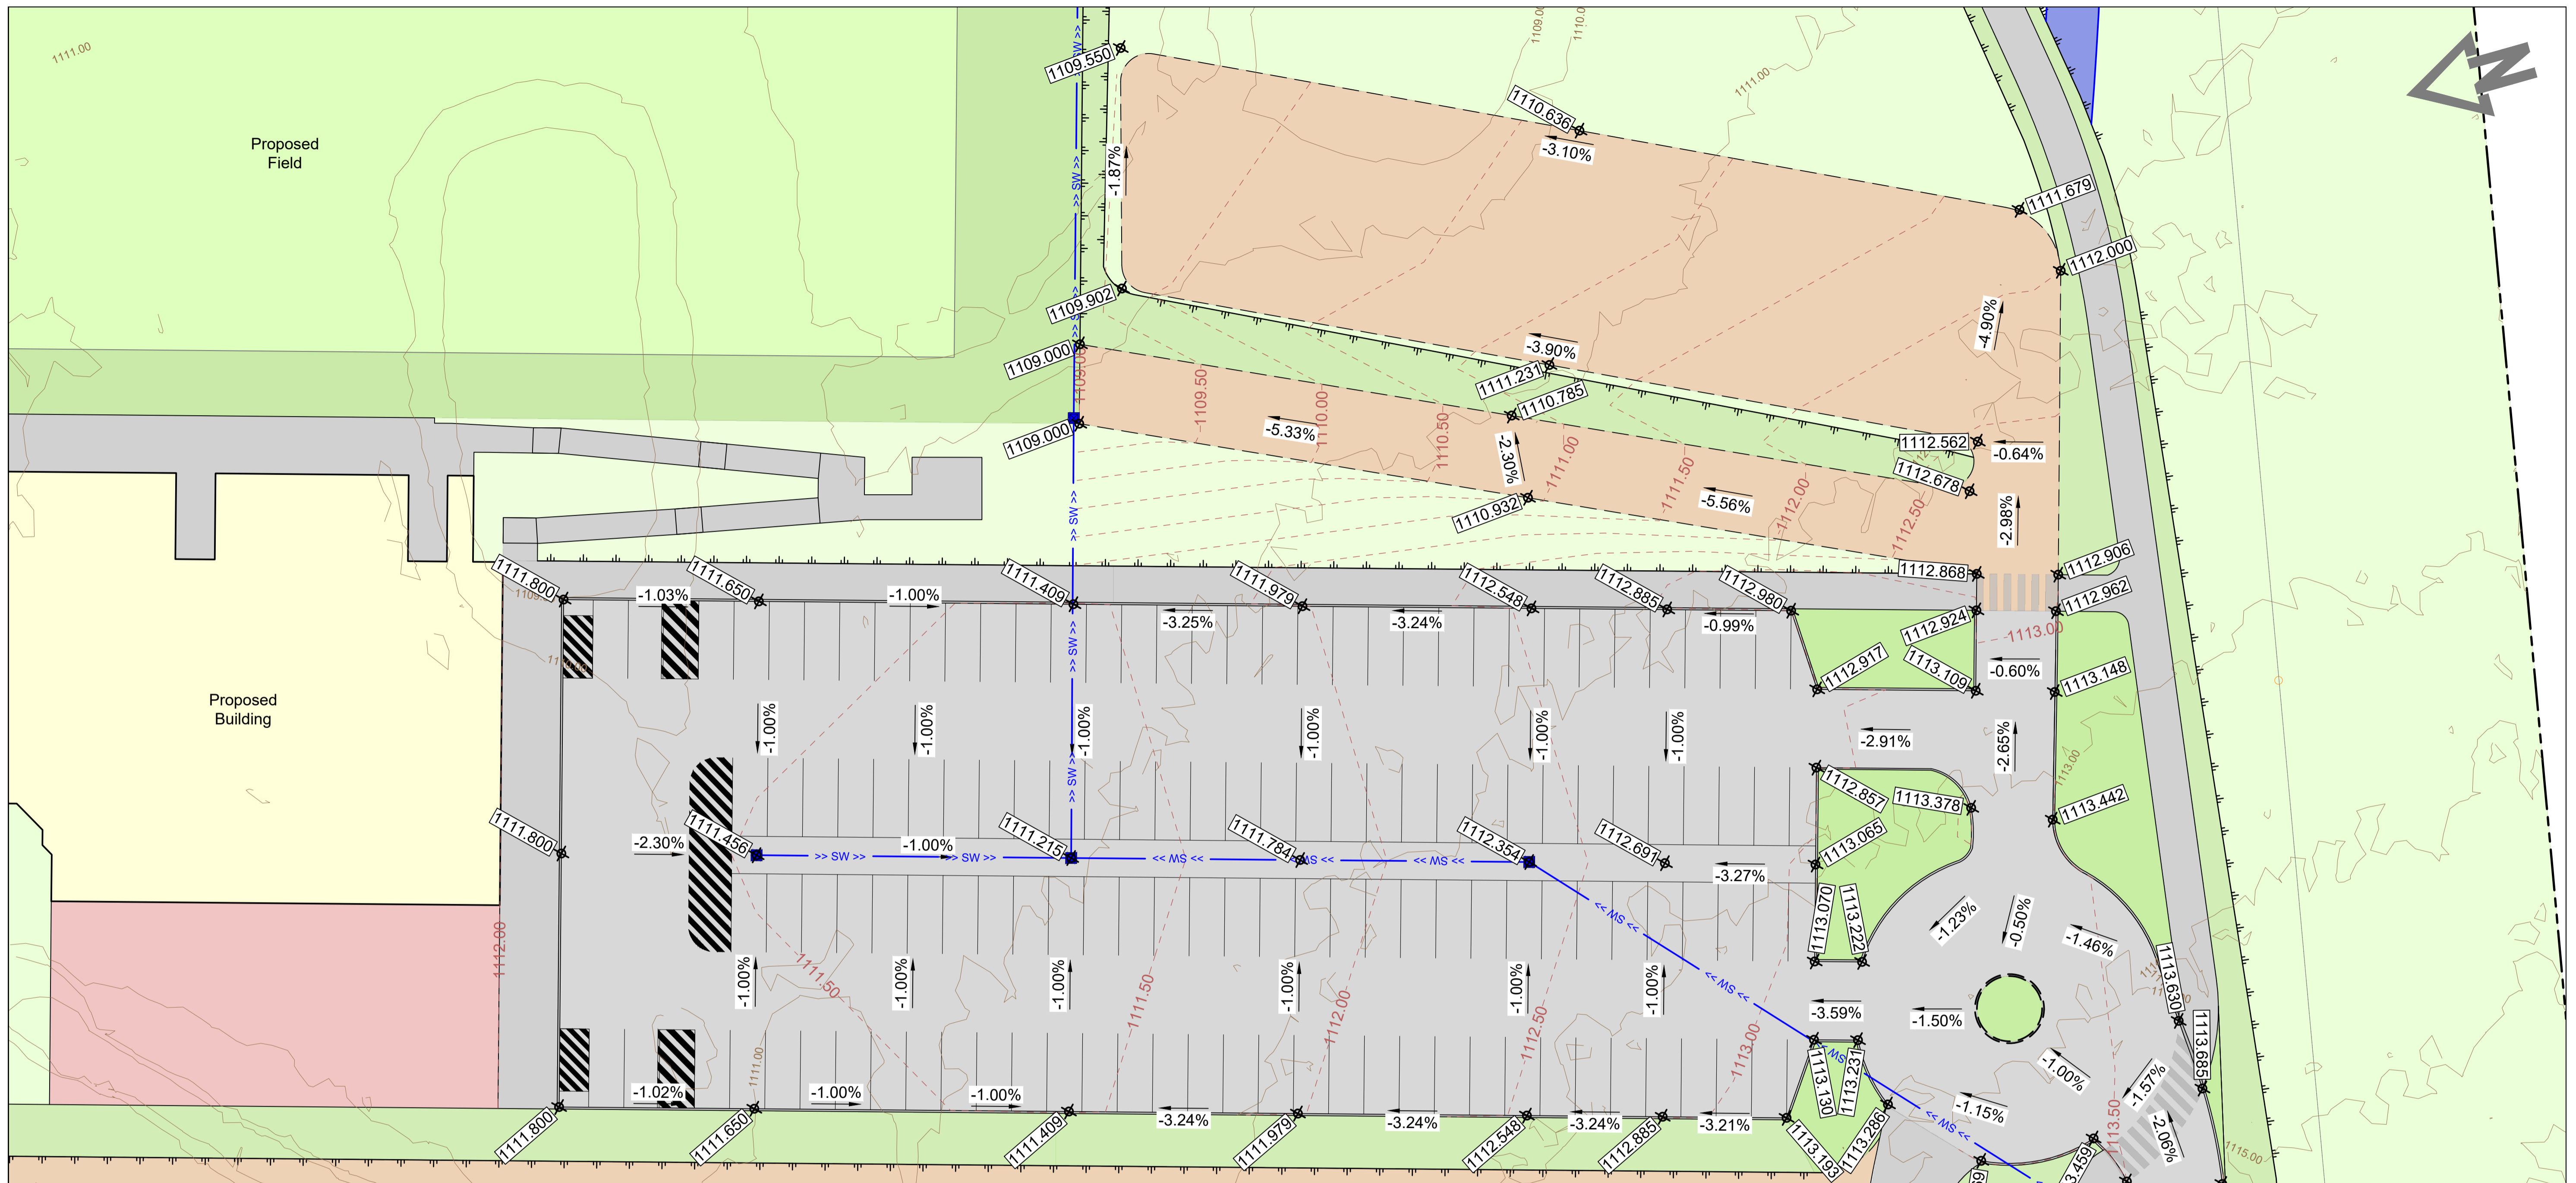

SEE BELOW FOR ROAD ACCESS

SEE ABOVE FOR CARPARK

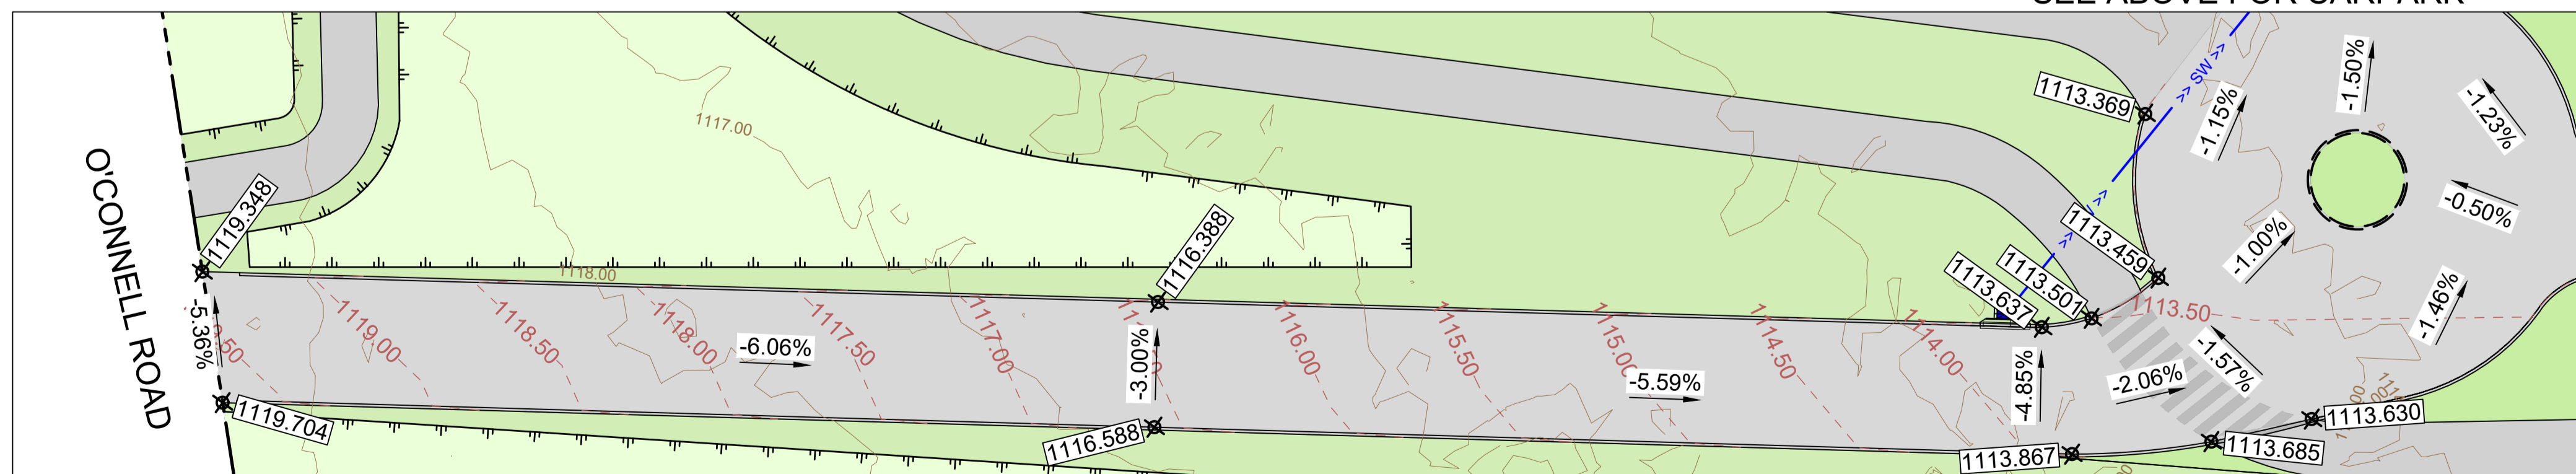

PLOT INFO: ...2023.0913-Civil-B.dwg, DATE: Oct 30, 2023 - 11:28:48

Amend	Date	Description	By	Amend	Date	Description	By
B	29/09/23	REVISED SITE LEVELS AND EARTHWORKS VOLUMES	TM				
A	25/09/23	FOR APPROVAL	JB				

Approved for Construction:

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Drawn: JB
 Designed: TM
 Checked: GBL
 Scale (A1): 1:250
 Date: 25/09/23

FOR APPROVAL

Garth Dean
 B.E. GDSTT FIEAust CPEng NER
 APEC Engineer IntPE (Aus) RBP
 (Vic/NT)

...2023.0913-Civil-B.dwg

PROPOSED SPORTS COMPLEX
 O'CONNELL ROAD
 OBERON NSW 2787

SITE GRADING PLAN

CROSSMULLER

CALARE CIVIL
 CONSULTING ENGINEERS

170 RANKIN STREET,
 BATHURST, N.S.W. 2795
 Tel: (02) 63323343 Fax: (02) 63318210

Job No.	2023.0913
DWG. No.	C02
Issue	B
No. in set	8

Overland Flow Path Calculation - Northern Swale

Mannings Channel Calculations								
=>	Q	1.92	(m3/sec)					
Mannings	$V=(1/n)R^{2/3}S^{1/2}$		R=A/P		Q=AV			
	n =	0.025	Grassed					
Where:	H = depth of channel	P = wetted parameter		A = Sectional Area				
	S = slope of channel							
Width of base	3		m		Top Width		5.4	
Batter slope (left)	1:	4						
Batter slope (Right)	1:	4						
CATCHMENT 1 - OVERFLOW 1								
H	P	A	S	R	V	Q	to 2% tolerance	VD
0.3	5.4738634	1.26	0.01	0.2301848	1.5023728	1.8929897	OK	0.4507118
	3	0	0.01	0	0	0	Low	0
	3	0	0.01	0	0	0	Low	0

Overflow Calculation - Dam Spillway

Mannings Channel Calculations								
=>	Q	3.57	(m3/sec)					
Mannings	$V=(1/n)R^{2/3}S^{1/2}$		R=A/P		Q=AV			
	n =	0.025	Grassed					
Where:	H = depth of channel	P = wetted parameter		A = Sectional Area				
	S = slope of channel							
Width of base	6.5		m		Top Width			
Batter slope (left)	1:	4						
Batter slope (Right)	1:	4						
CATCHMENT 1 - OVERFLOW 1								
H	P	A	S	R	V	Q	to 2% tolerance	VD
0.28	8.8089392	2.1336	0.01	0.2422085	1.5542453	3.3161378	Low	0.4351887
0.3	8.9738634	2.31	0.01	0.2574142	1.6186327	3.7390416	High	0.4855898
0.32	9.1387876	2.4896	0.01	0.2724213	1.6809468	4.1848851	High	0.537903

Overland Flow Path Calculation - Southern Swale

Mannings Channel Calculations								
=>	Q	1.02	(m3/sec)					
Mannings	$V=(1/n)R^{2/3}S^{1/2}$		R=A/P		Q=AV			
	n =	0.025	Grassed					
Where:	H = depth of channel	P = wetted parameter		A = Sectional Area				
	S = slope of channel							
Width of base	1.5		m		Top Width		3.9	
Batter slope (left)	1:	4						
Batter slope (Right)	1:	4						
CATCHMENT 1 - OVERFLOW 1								
H	P	A	S	R	V	Q	to 2% tolerance	VD
0.3	3.9738634	0.81	0.01	0.2038319	1.3853984	1.1221727	High	0.4156195
	1.5	0	0.01	0	0	0	Low	0
	1.5	0	0.01	0	0	0	Low	0

20% AEP Results


SUB-CATCHMENT DETAILS							
Name	Max Flow Q	EIA Max Q	Remainin Max Q	EIA Tc	RIA Tc	PA Tc	Due to Storm
	(cu.m/s)	(cu.m/s)	(cu.m/s)	(cu.m/s)	(min)	(min)	(min)
Ex-Cat	1.862	0	1.862	21	2	21	20% AEP, 20 min burst, Storm 9
Dev-Cat	1.863	0.28	1.583	21	2	21	20% AEP, 20 min burst, Storm 5

1% AEP Results

SUB-CATCHMENT DETAILS							
Name	Max Flow Q	EIA Max Q	Remainin Max Q	EIA Tc	RIA Tc	PA Tc	Due to Storm
	(cu.m/s)	(cu.m/s)	(cu.m/s)	(cu.m/s)	(min)	(min)	(min)
Ex-Cat	3.567	0	3.567	21	2	21	1% AEP, 20 min burst, Storm 6
Dev-Cat	3.568	0.536	3.032	21	2	21	1% AEP, 20 min burst, Storm 4

Note:
 • An IL/CL model has been run on Watercom Drains, to determine the increase in site runoff in the post development scenario. This demonstrated a negligible increase in runoff in the 20% AEP and 1% AEP rainfall events, and therefore no stormwater detention is proposed for the development

PLOT INFO: ...2023.0913-Civil-B.dwg, DATE: Oct 30, 2023 - 11:28:48

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				Drawn: JB Designed: TM Checked: GBL Scale (A1): AS SHOWN Date: 25/09/23		FOR APPROVAL		STORMWATER CALCULATIONS		DWG. No. Issue SW01 B		No. in set 8	
Amend Date Description By Amend Date Description By				Garth Dean B.E. GDSTT FIEAust CPEng NER APEC Engineer IntPE (Aus) RBP (Vic/NT)				CROSSMULLER					